

Norwalk  
Building 43

Norwalk, California

Skidmore, Owings & Merrill  
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One Maritime Plaza  
San Francisco, California

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Approved for the Owner by

Approved for the Architect by

Drawn by D. PAUTAS Job Number 10243-200

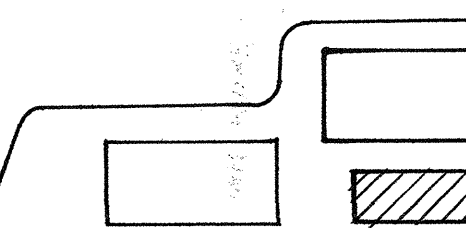
Checked by Date

Revisions

No.	Revisions Indicated thus Δ:	Date
	ISSUED FOR METAL DECK BID	11-23-81
	ISSUED FOR CONCRETE BID	2-23-81
	ISSUED FOR FOUNDATION & PILE PERMIT	
Δ	ADDENDUM NO. 12	12-18-81
Δ	ADDENDUM NO. 16	1-15-82
	ISSUED FOR MILL ORDER ONLY	
Δ	ADDENDUM NO. 26	1-24-82
Δ	ISSUE FOR DETAILING ADDENDUM NO. 26	2-24-82
	ADDENDUM NO. 37	4-30-82
Δ	ADDENDUM NO. 40	5-12-82
Δ	ADDENDUM NO. 63	7-22-82
	ADDENDUM NO. 66	8-5-82
Δ	ADDENDUM NO. 92	11-24-82

Ernie B. Tryde SE 1117

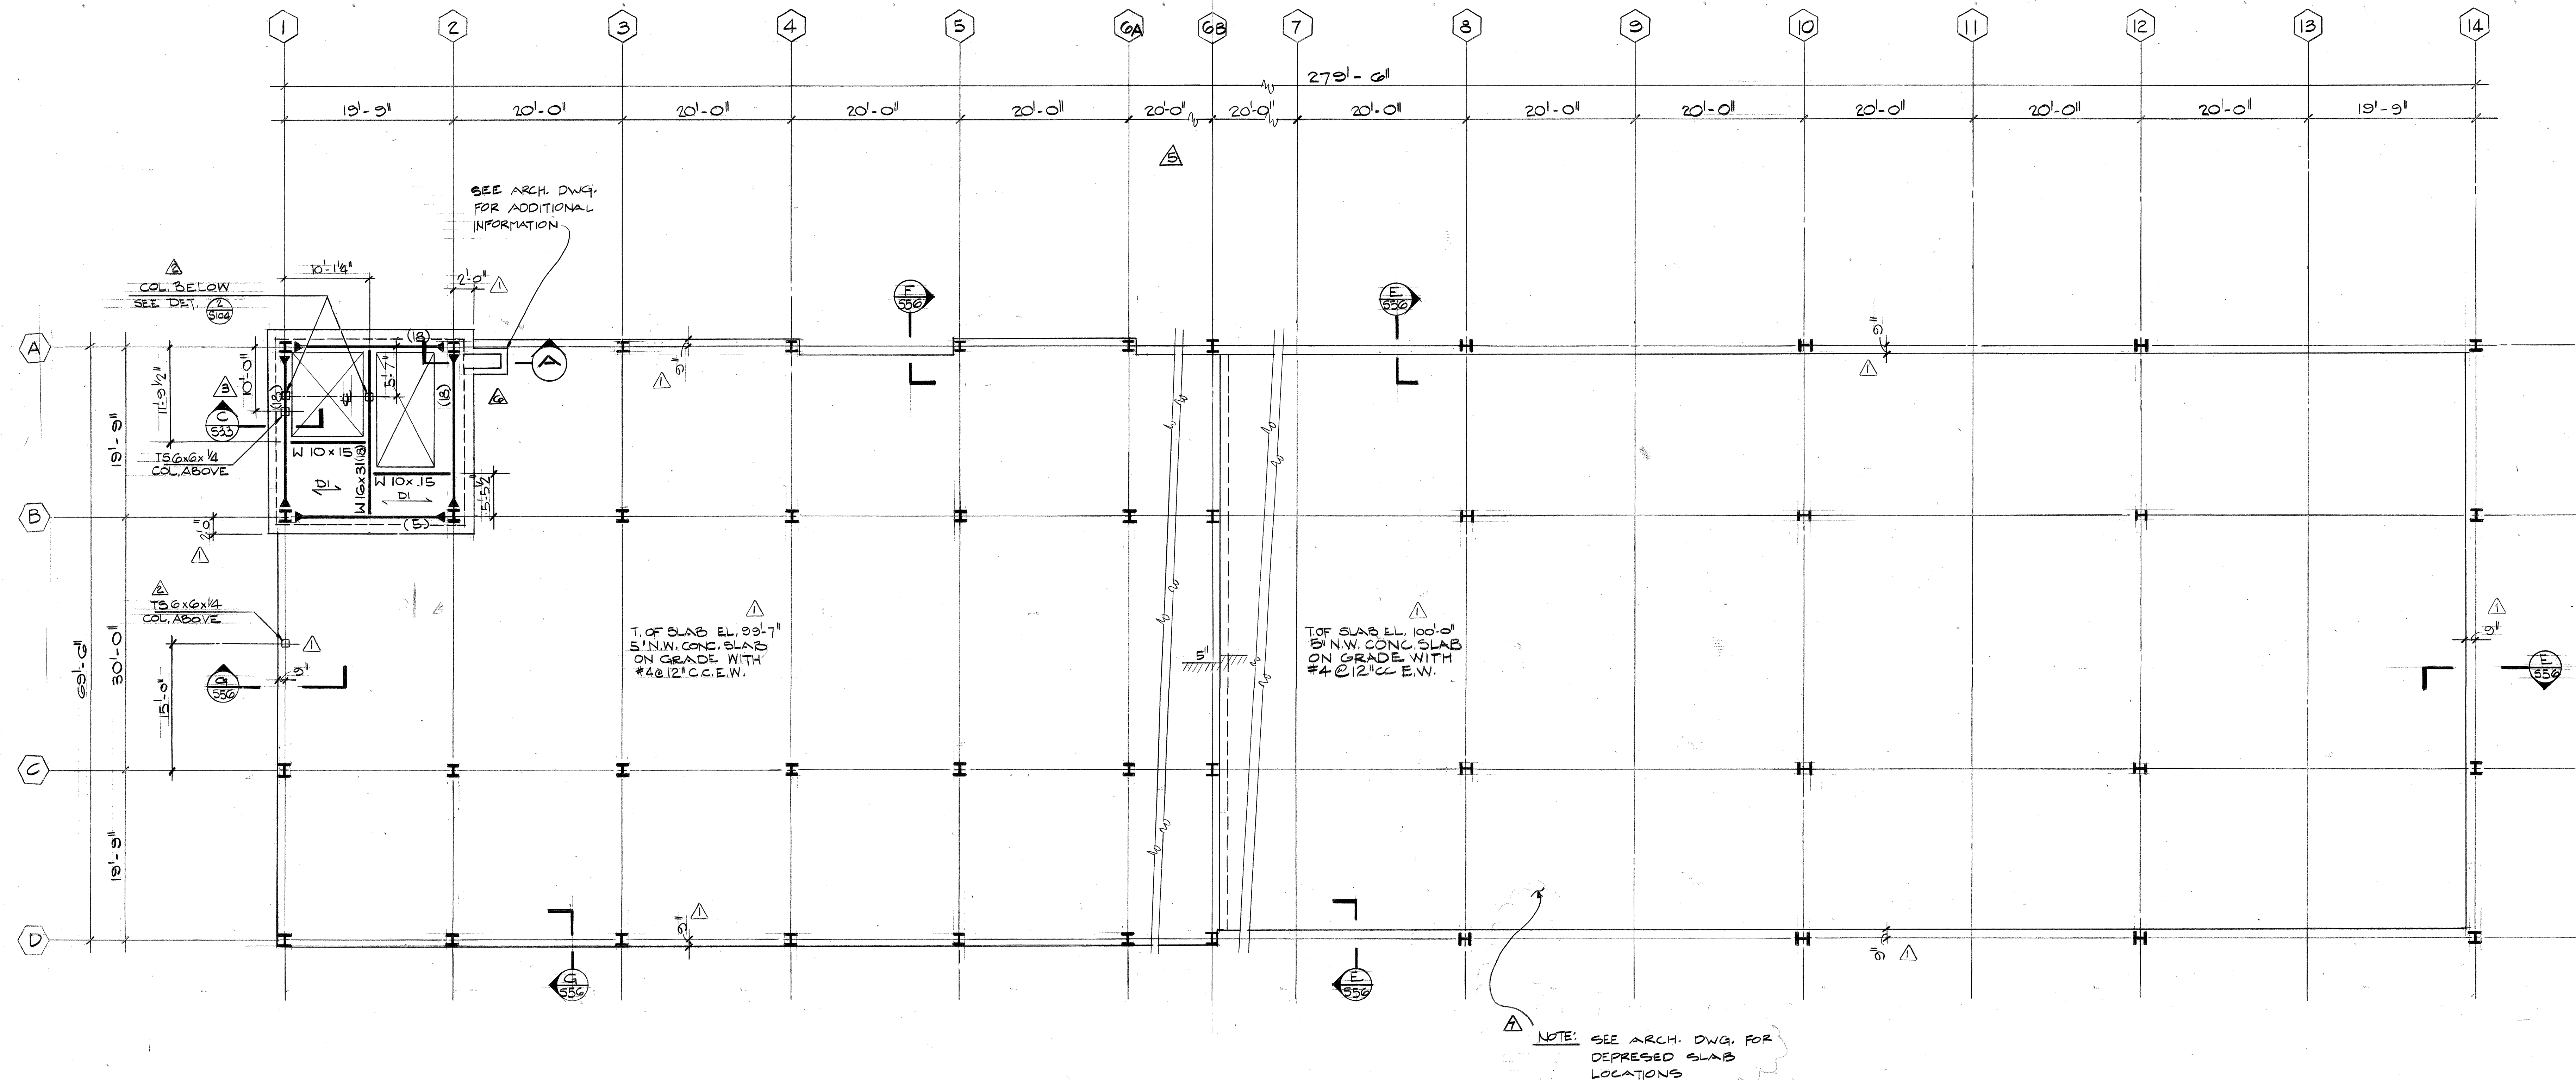
KEY PLAN



Cafeteria Level 2 /  
Ground Floor  
Framing Plan

SCALE 1/8" = 1'-0"

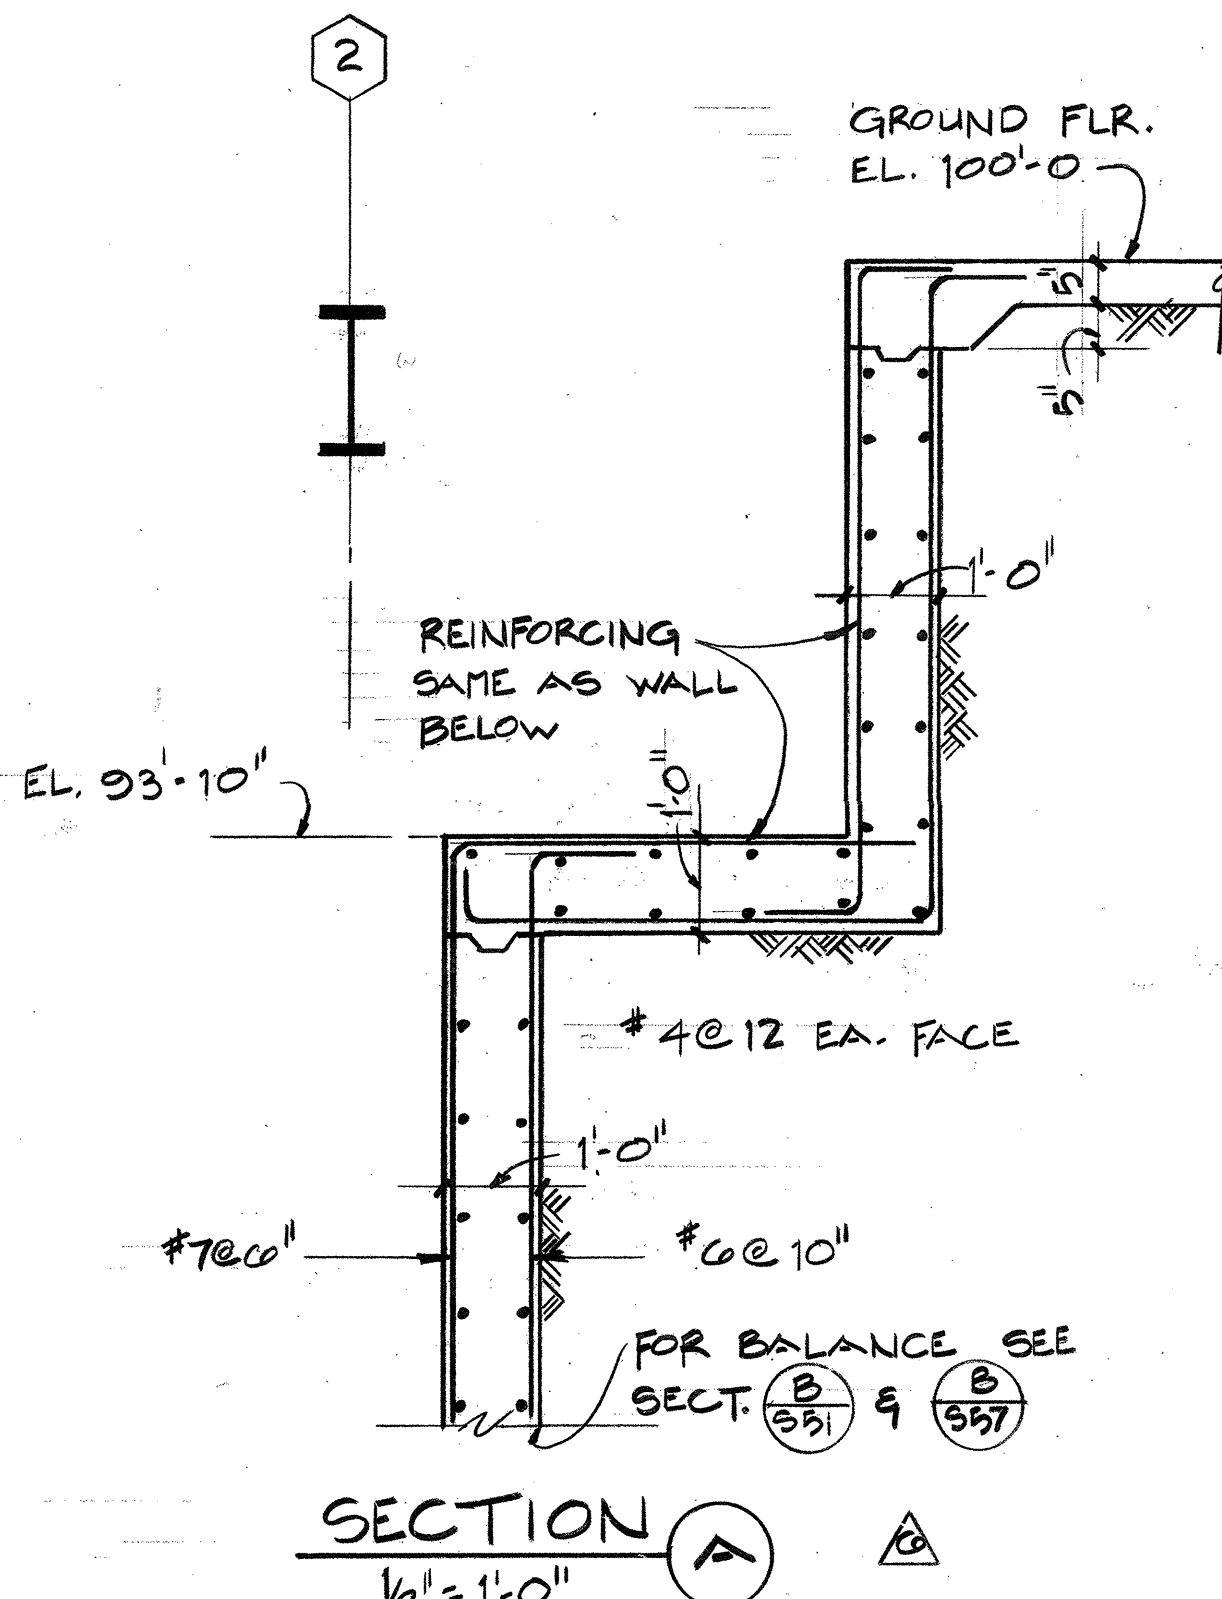
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CAFETERIA-LEVEL 2, GROUND FLOOR PLAN  
1/8" = 1'-0"

DESIGN LOADS	
TYPICAL	POF.
2 1/2" N.W. CONC. FILL ON 5" METAL DECK	53
CEILING	5
FIRE PROOF & MISC. PARTITIONS	20
DEAD LOAD	83
LIVE LOAD (1)	100
(1) NOT REDUCED	

LOAD CAPACITIES FOR DESIGN ONLY  
NOT FOR CONSTRUCTION



NOTES:  
REFERENCE ELEVATION 99'-7"  
TOP OF STEEL [60'-5 1/2"] WITH RESPECT TO  
REFERENCE ELEVATION UNLESS NOTED  
THUS = [1'-4"]  
FOR GENERAL NOTES SEE  
FOR TYPICAL STEEL DETAILS SEE  
FOR TYPICAL METAL DECK DETAILS SEE  
FOR COLUMNS & FRAME GIRDERS SEE