

Norwalk  
Building 43

Norwalk, California

Skidmore, Owings & Merrill  
Architects/Engineers  
One Maritime Plaza  
San Francisco, California

Jaros, Baum & Bolles  
Consulting Engineers  
345 Park Avenue  
New York, New York

Approved for the Owner by

Approved for the Architect by

Drawn by D. PALOTAS Job Number 10235-200


Checked by Date 9.2.81

Revisions

No.	Revisions Indicated Thus	Date
1	ISSUE FOR STRUCTURAL STEEL SCOPE BID	9.2.81
2	ISSUE FOR STRUCTURAL STEEL MILL ORDER	9.23.81
3	ADDENDUM NO. 1	10.7.81
4	ISSUE FOR STRUCTURAL STEEL DETAILING	10.28.81
5	ADDENDUM NO. 2	11.3.81
6	ISSUED FOR METAL DECK BID	11.3.81
7	ADDENDUM NO. 3	11.6.81
8	ADDENDUM NO. 4	12.7.81
9	ISSUED FOR CONCRETE BID	2.8.82
10	ISSUED FOR FOUNDATION & PILE PERMIT	1.29.82
11	ISSUED FOR PLAN CHECK	2.24.82
12	ADDENDUM NO. 20	4.30.82
13	ADDENDUM NO. 37	5.17.82
14	ADDENDUM NO. 41	

Scale 1/8" = 1' - 0"


KEY PLAN

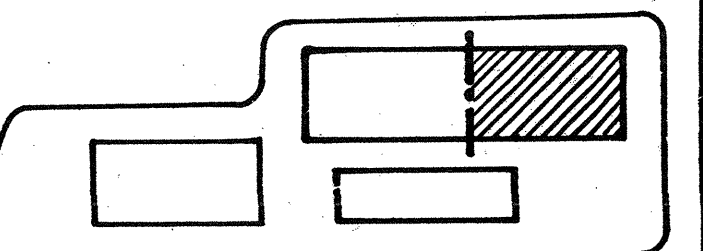

Level 3 -  
Framing Plan / East


Scale : 1/8" = 1' - 0"

S 7

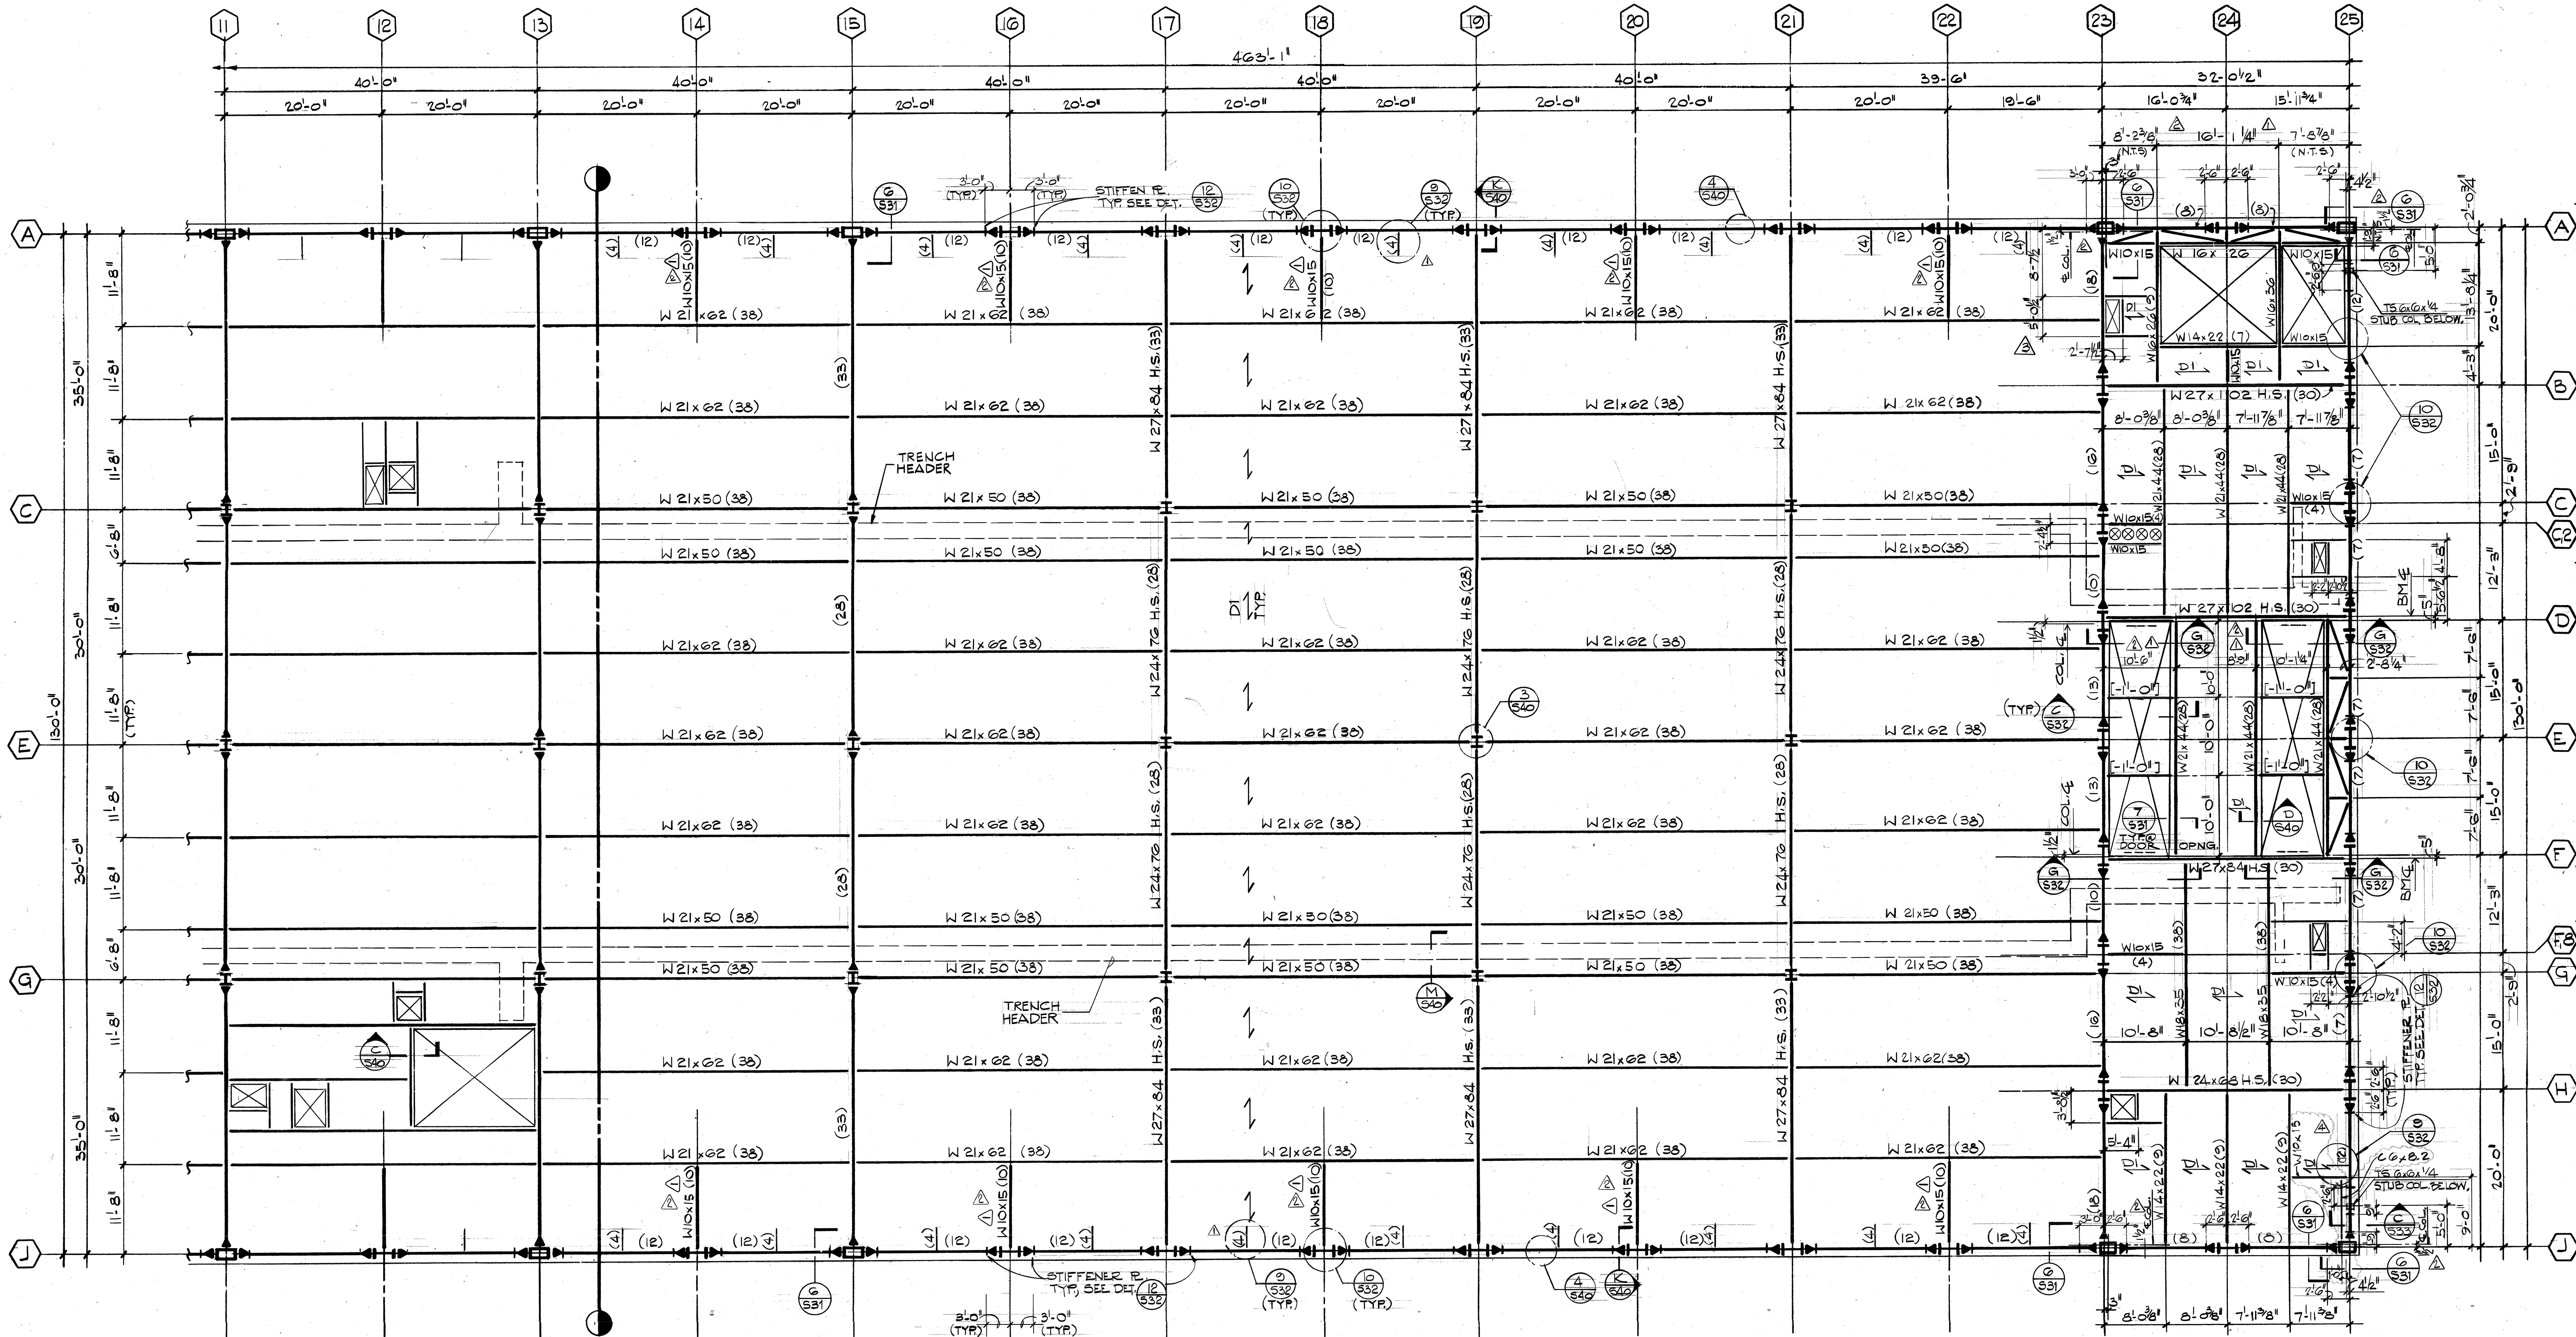

LEVEL 3 FRAMING PLAN (EAST HALF)

1/8" = 1'-0"

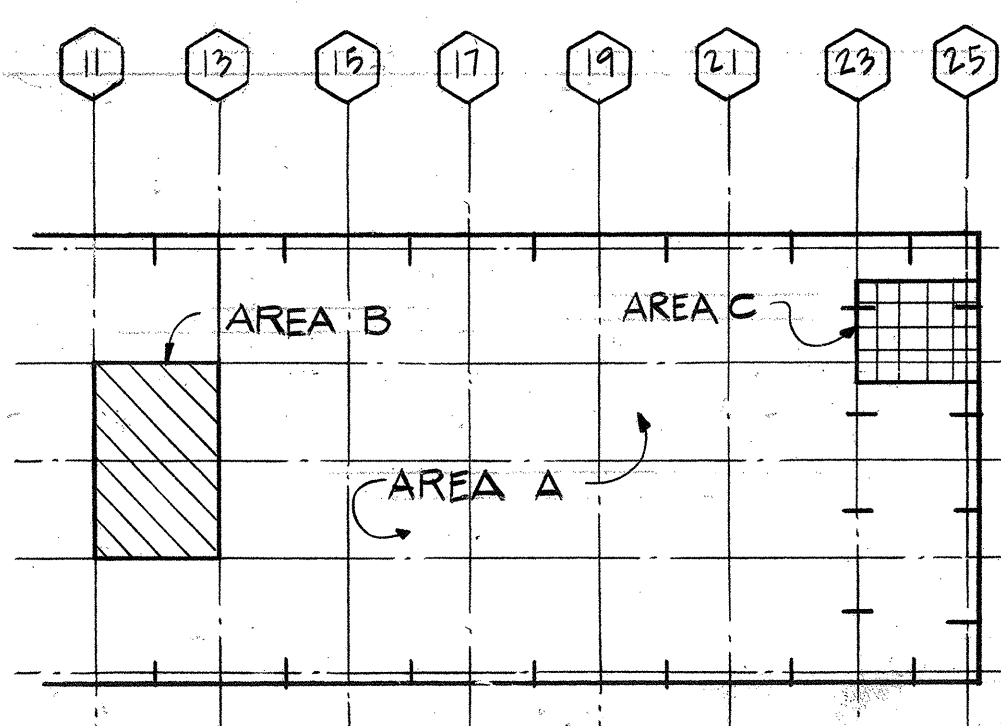

AREA A TYPICAL	PSF	AREA B LIGHT STORE	PSF	AREA C FAN ROOM	PSF
2 1/2" N.W. CONC. FILL ON 3" METAL DECK	53	2 1/2" N.W. CONC. FILL ON 3" METAL DECK	53	2 1/2" N.W. CONC. FILL ON 3" METAL DECK	53
PARTITIONS	20	PARTITIONS	20	4" FLOATING FLOOR (1)	50
CEILING	5	CEILING	5	6" HOUSEKEEPING PAD (1)	75
FIREROOF & MISC.	5	FIREROOF & MISC.	5	CEILING	5
				FIREROOF & MISC.	5
DEAD LOAD	83	DEAD LOAD	83	DEAD LOAD	188
LIVE LOAD (1)	50	LIVE LOAD (2)	125	LIVE LOAD (1)	75

(1) REDUCED  
(2) NOT REDUCED

NOTES

- REFERENCE ELEVATION = 110'-0" TOP OF STEEL (0'-5 1/2") WITH RESPECT TO REFERENCE ELEVATION UNLESS NOTED
- FOR GENERAL NOTES SEE (530) SEE (540) FOR TYPICAL STEEL DETAILS SEE (515) SEE (516) FOR COLUMNS & FRAME GIRDERS SEE (532)
- FOR MISCELLANEOUS FRAMING AROUND FLOOR OPENINGS SEE (532)