

Norwalk
Building 43

Norwalk, California

Skidmore, Owings & Merrill
Architects/Engineers
One Maritime Plaza
San Francisco, California

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Consulting Engineers
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New York, New York

Approved for the Owner by

Approved for the Architect by


Drawn by
D. PALOTAS
Job Number
10293-200
Checked by
Date

Revisions

No.	Revisions Indicated there Δ:	Date
	ISSUED FOR METAL DECK BID.	11-3-81
Δ	ADDENDUM NO. 8	11-8-81
Δ	ISSUED FOR CONCRETE BID	12-8-81
Δ	ISSUED FOR FOUNDATION & PILE PERMIT	
Δ	ADDENDUM NO. 16	1-15-82
Δ	ISSUED FOR MLL ORDER ONLY	
Δ	ADDENDUM NO. 20	1-21-82
Δ	ADDENDUM NO. 28	2-24-82
Δ	ISSUE FOR DETAILING	3-9-82
Δ	ADDENDUM NO. 32	3-26-82
Δ	ADDENDUM NO. 37	4-30-82
Δ	ISSUED FOR BUILDING PERMIT	
Δ	ADDENDUM NO. 40	5-12-82
Δ	ADDENDUM NO. 59	7-20-82
Δ	ADDENDUM NO. 66	8-5-82
Δ	ISSUED FOR PLAN CHECK	
Δ	ADDENDUM NO. 136	3-17-84

Encl. R. Type SE1117


KEY PLAN

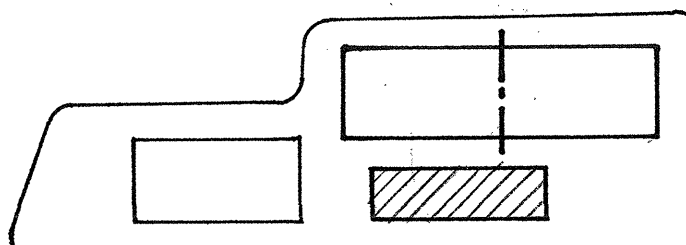

Cafeteria Roof
Framing Plan

Scale : 1/8" = 1' - 0"



S 103

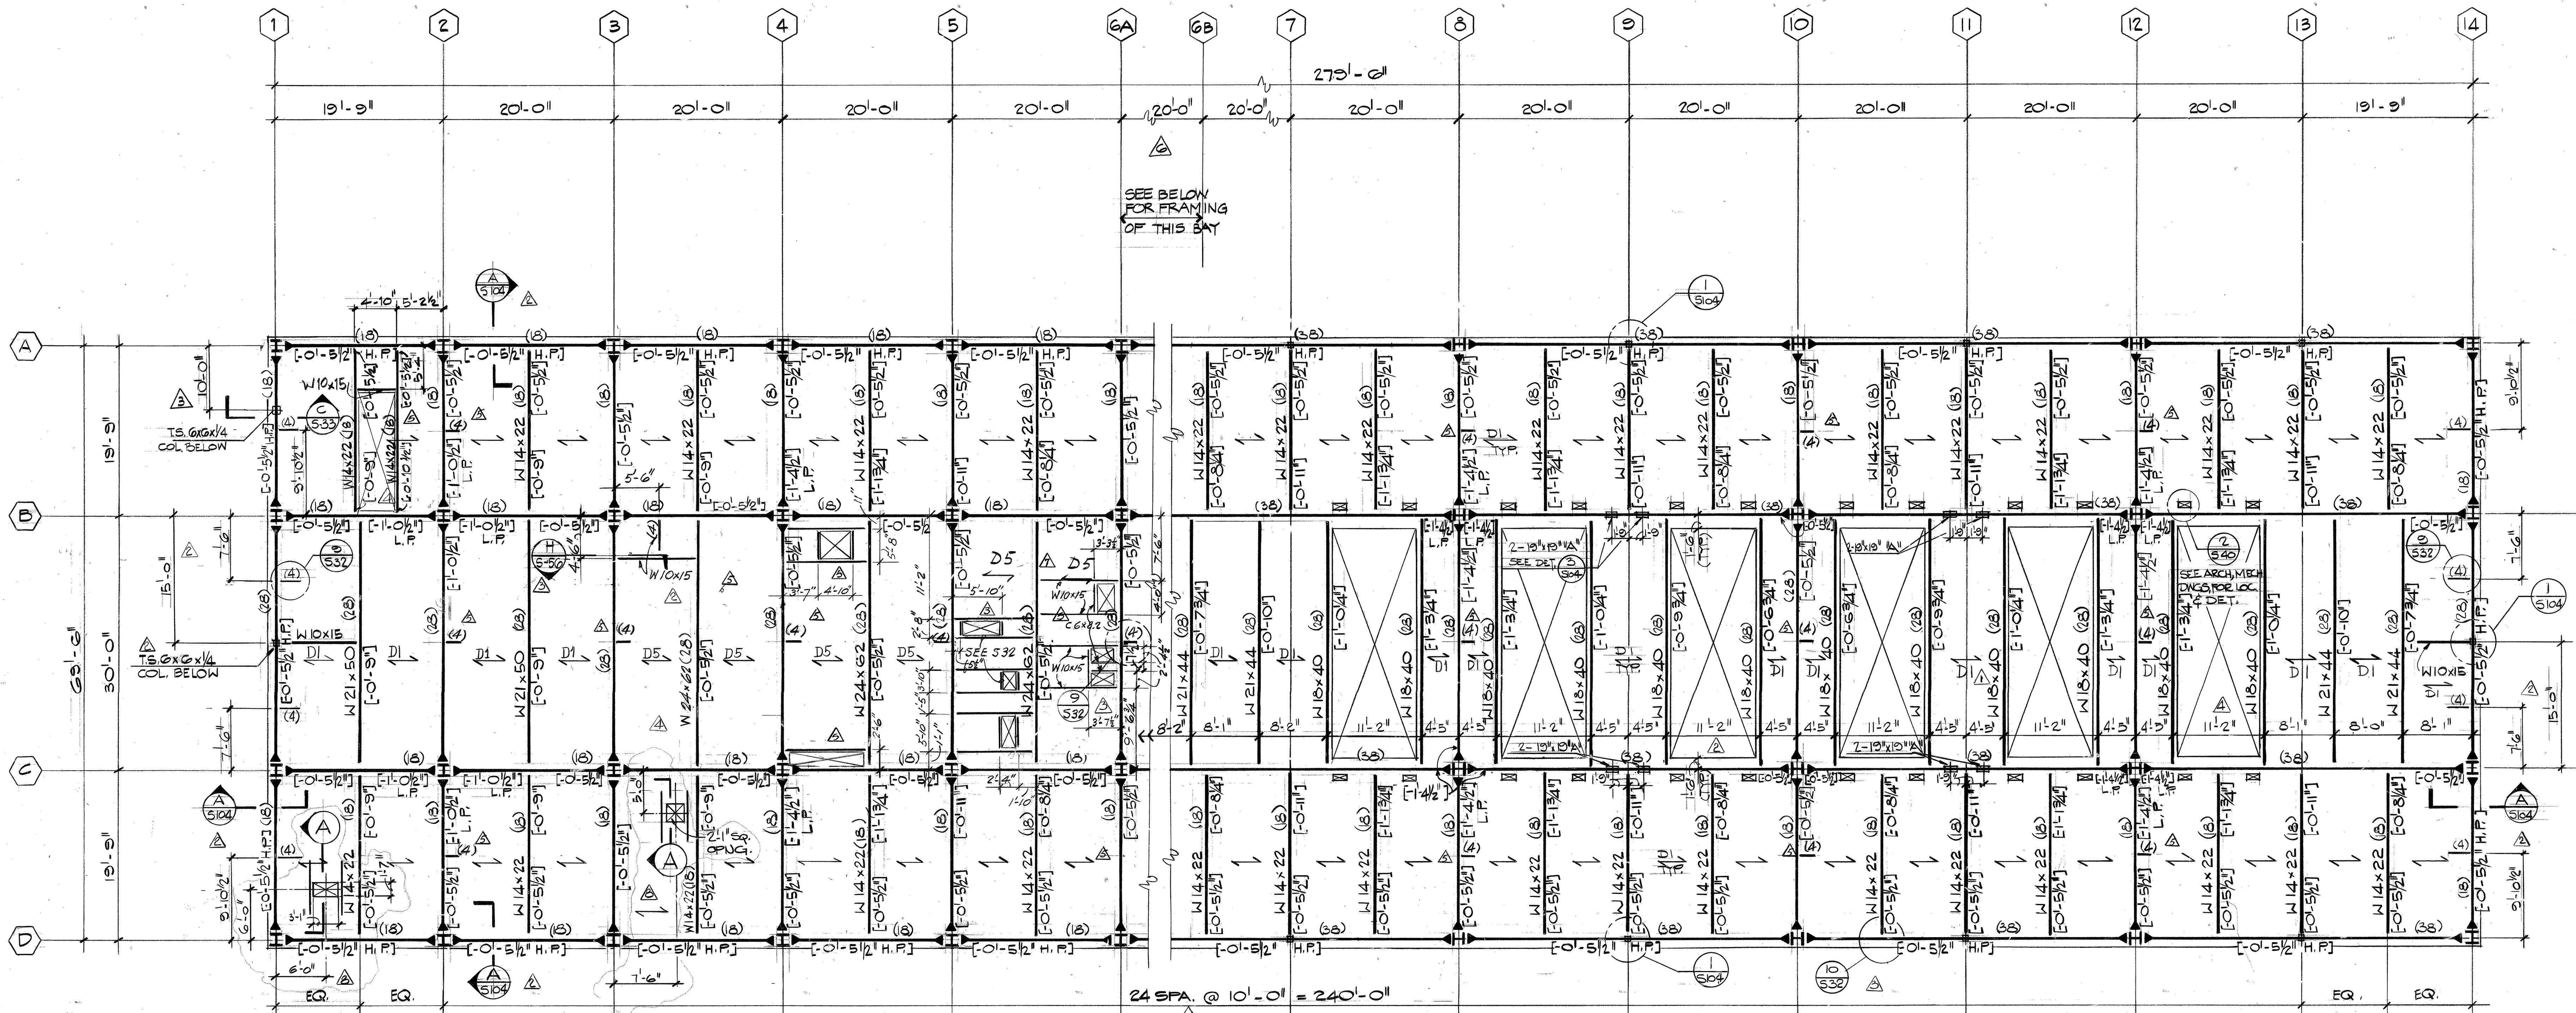

CAFETERIA ROOF FRAMING PLAN
SCALE 1/8" = 1'-0"

DESIGN LOADS	
PLINTHOUSE FLOOR PSF	ROOF PSF
5" N.W. CONC. FILL ON 3" METAL DECK	2 1/2" N.W. CONC. FILL ON 3" METAL DECK
6" HOUSEKEEPING PAD	CEILING
CEILING	ROOFING & INSUL.
FIREPROOF & MISC.	FIREPROOF & MISC.
DEAD LOAD 170	DEAD LOAD 173
LIVE LOAD (1)	LIVE LOAD (1)

(1) NON REDUCED
LOAD CAPACITIES FOR DESIGN ONLY
NOT FOR CONSTRUCTION

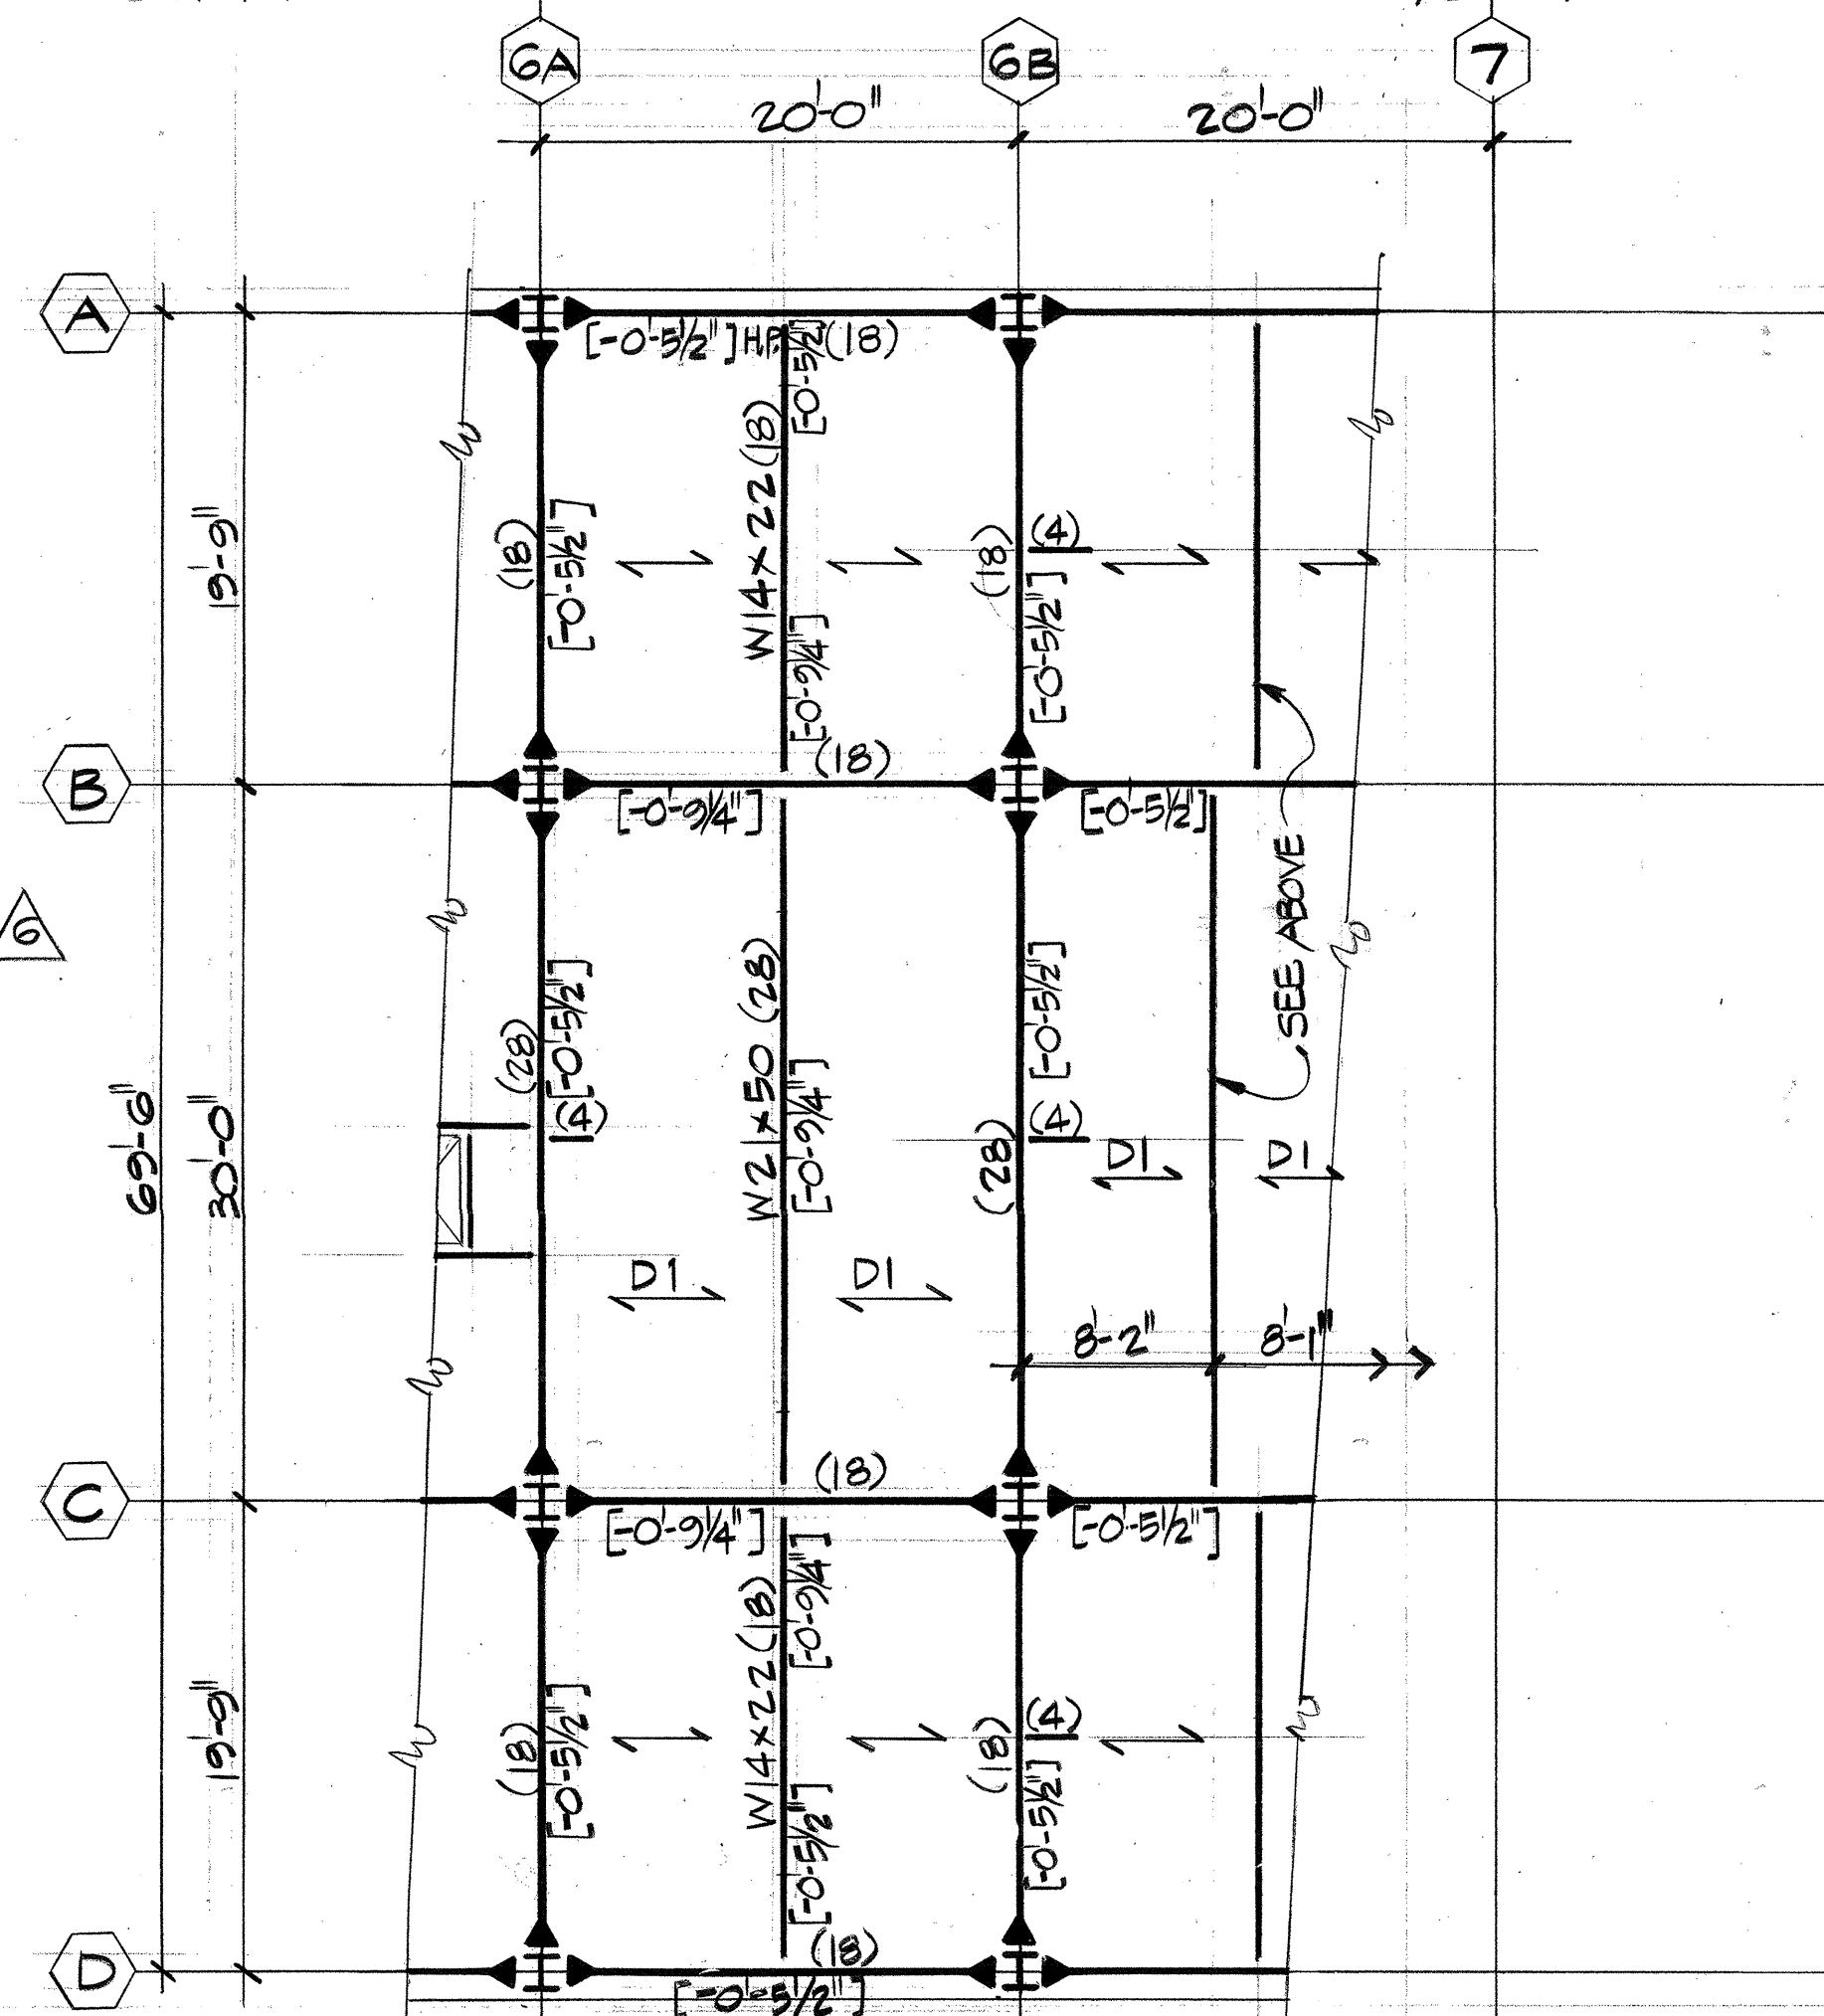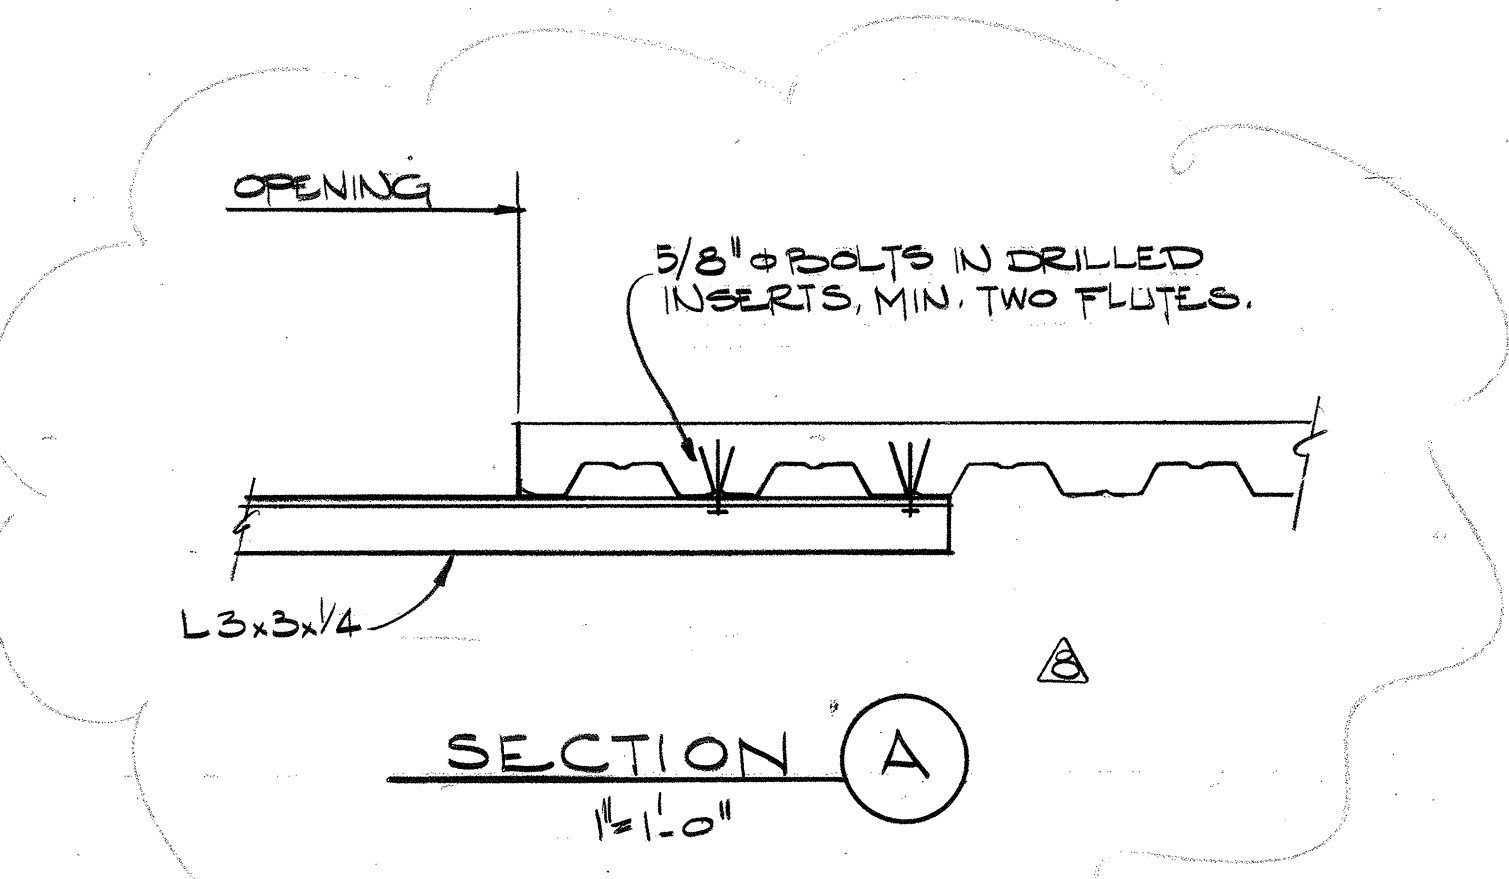

NOTES

- REFERENCE ELEVATION -115'-6" (H.P.) TOP OF STEEL [C.O.S. 1/2"] WITH RESPECT TO REFERENCE ELEVATION UNLESS NOTED THIS [C.O.S. 1/2"]
- FOR GENERAL NOTES SEE [C.O.S. 1/2"]
- FOR TYPICAL STEEL DETAILS SEE [C.O.S. 1/2"]
- FOR TYPICAL METAL DECK DETAILS SEE [C.O.S. 1/2"]
- FOR COLUMN & FRAME GIRDERS SEE [C.O.S. 1/2"]
- COORDINATE WITH MECH. CONTRACTOR FOR LOCATION & SIZE OF OPENINGS.